
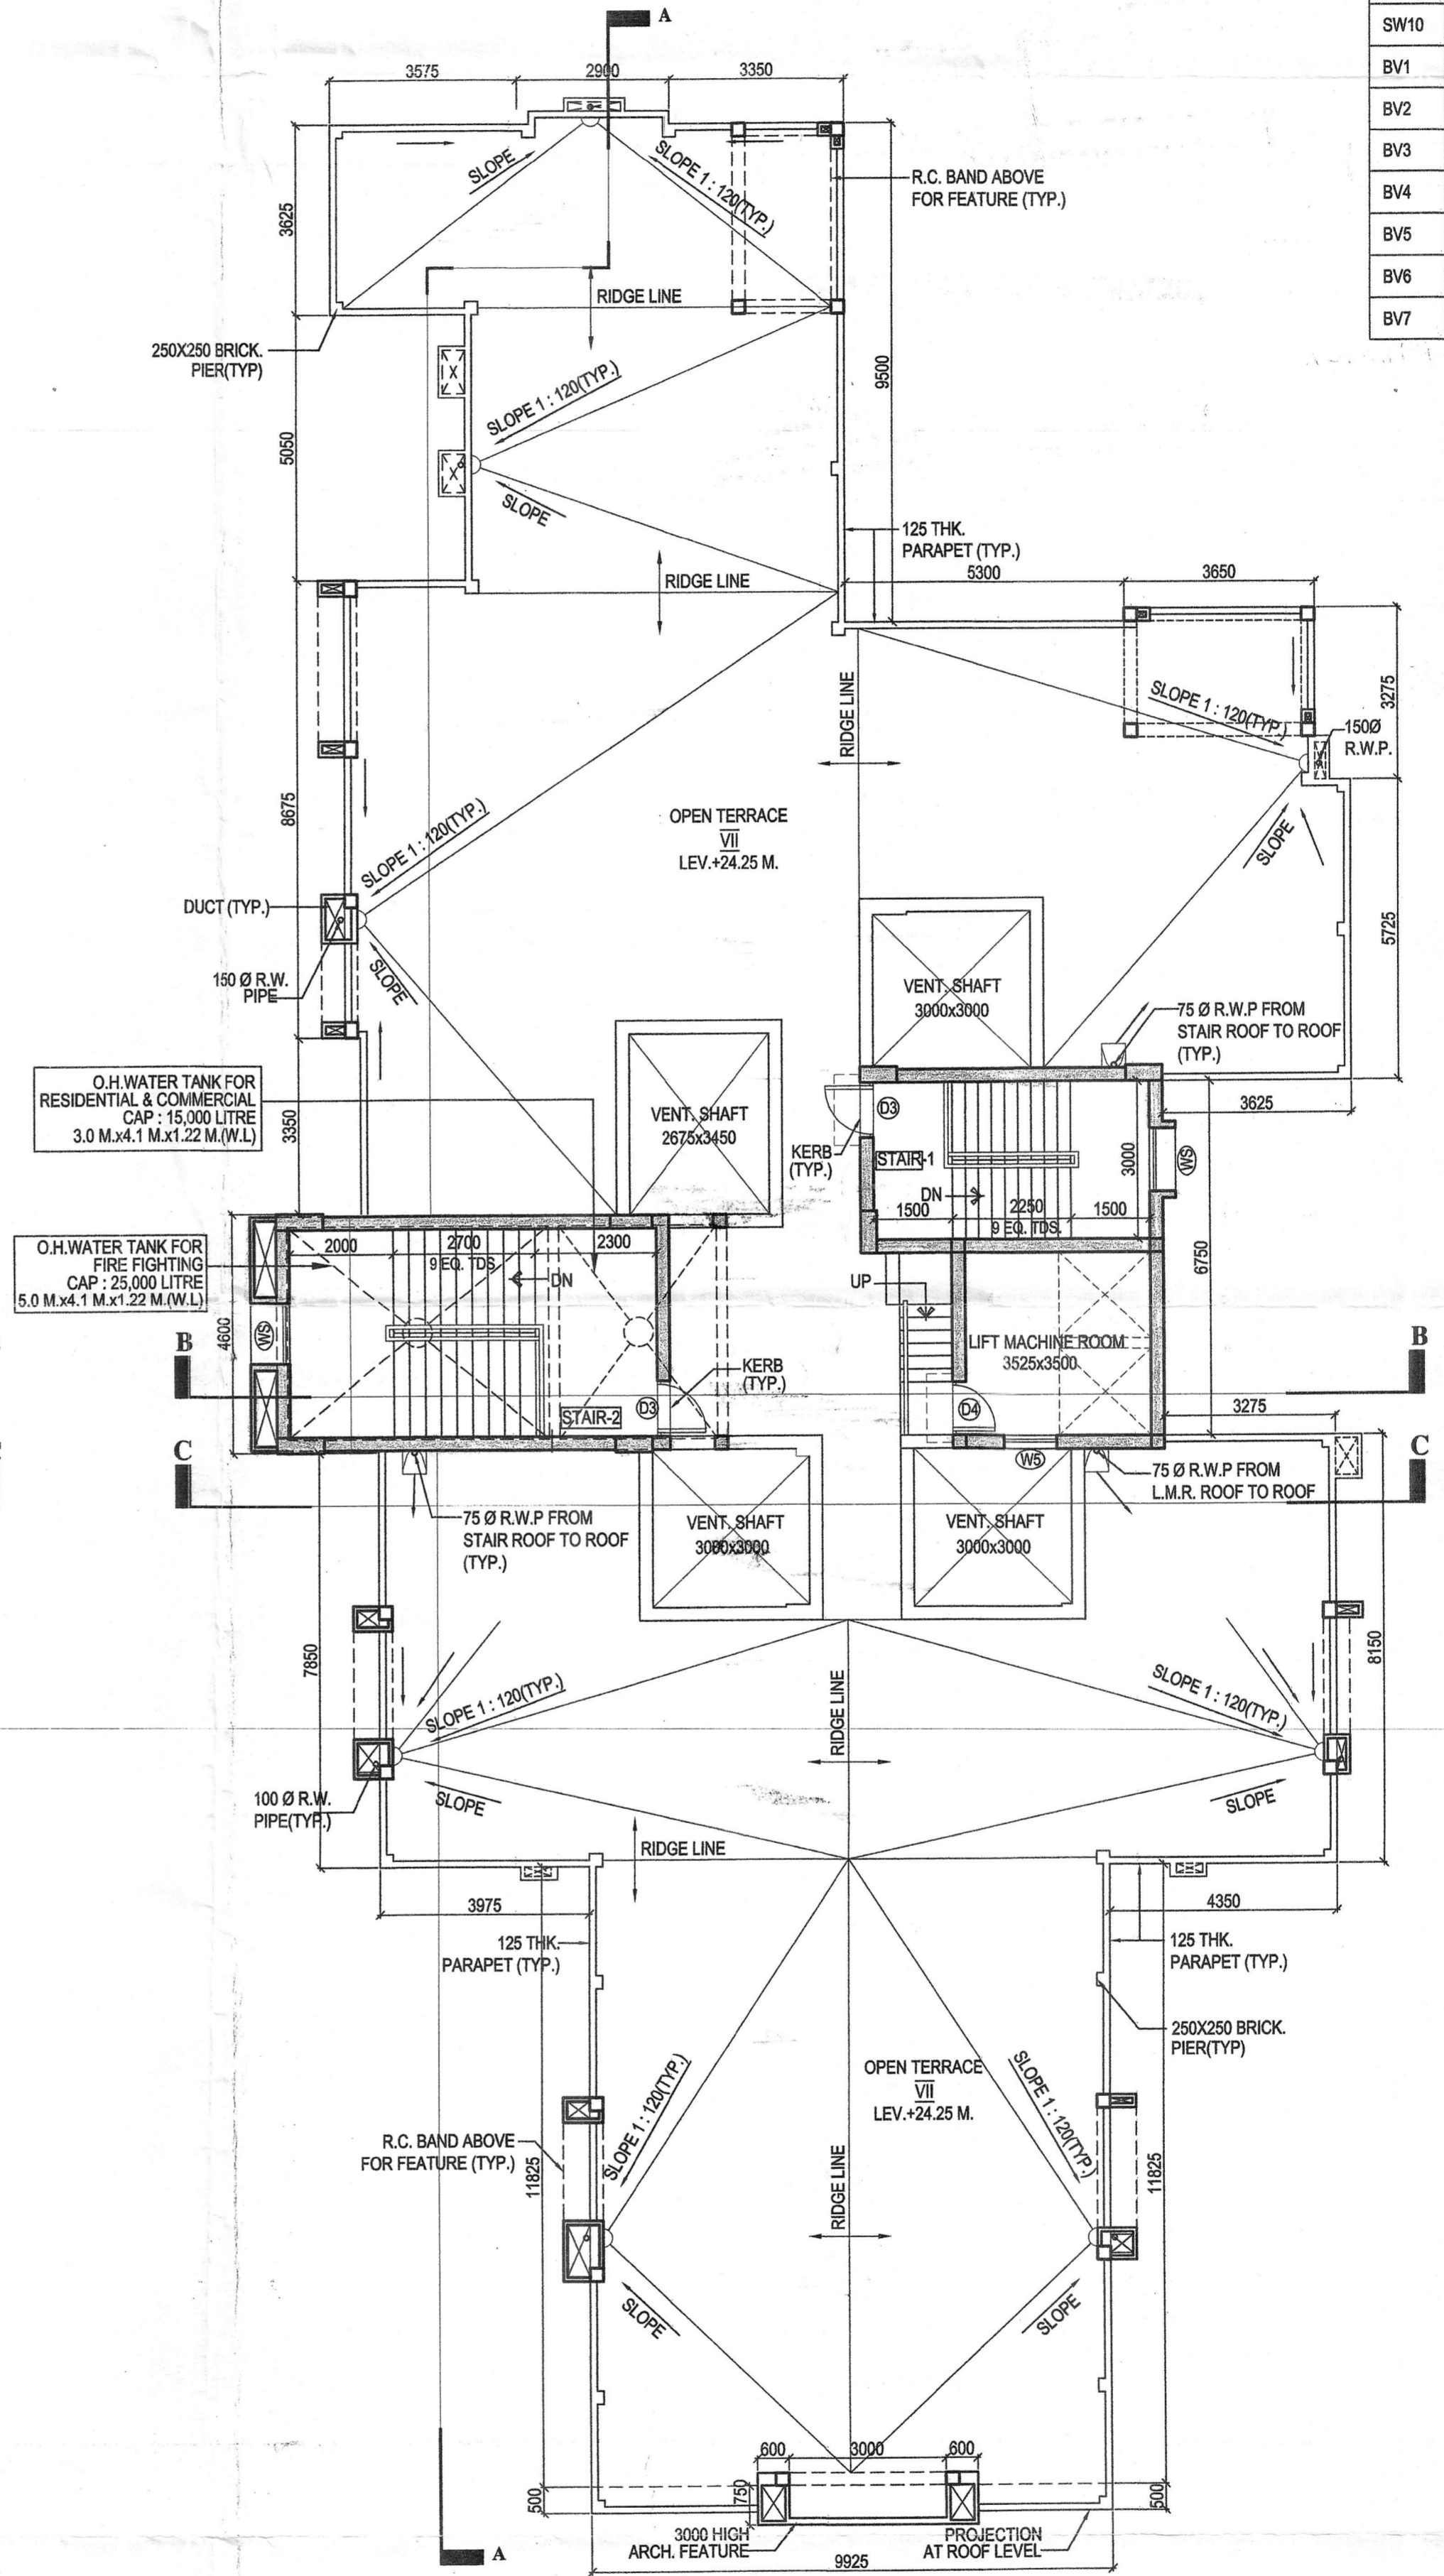


SCHEDULE OF DOORS				SCHEDULE OF WINDOWS			
DOOR MKD.	WIDTH	HEIGHT	REMARKS	WINDOW MKD.	WIDTH	HEIGHT	REMARKS
D1	1500	2400	ALUMINIUM FULLY GLAZED	W1	2000	1200	ALUMINIUM FULLY GLAZED
D2	1200	2100	ALUMINIUM FULLY GLAZED	W2	1500	1200	ALUMINIUM FULLY GLAZED
D3	1050	2100	WOODEN FLUSH SOLID	W3	1250	1200	ALUMINIUM FULLY GLAZED
D4	1000	2100	WOODEN FLUSH SOLID	W4	1200	1200	ALUMINIUM FULLY GLAZED
D5	900	2100	WOODEN FLUSH SOLID	W5	1000	1200	ALUMINIUM FULLY GLAZED
D6	850	2100	WOODEN FLUSH SOLID	W6	750	1200	ALUMINIUM FULLY GLAZED
D7	750	2100	WOODEN FLUSH SOLID	W7	600	900	ALUMINIUM FULLY GLAZED
FCD	1050	2100	FIRE CHECK DOOR AS VENDOR	WS	1200	1200	ALUMINIUM FULLY GLAZED
DW1	3400	2400	ALUMINIUM FULLY GLAZED	CW1	10025	3250	CURTAIN WALL
DW2	3000	2100	ALUMINIUM FULLY GLAZED	SW1	8200	3250	AL FULLY GLAZED SHOP WINDOW
DW3	2775	2100	ALUMINIUM FULLY GLAZED	SW2	3700	2400	AL FULLY GLAZED SHOP WINDOW
DW4	2400	2100	ALUMINIUM FULLY GLAZED	SW2	3800	2400	AL FULLY GLAZED SHOP WINDOW
DW5	2150	2100	ALUMINIUM FULLY GLAZED	SW3	3025	2400	AL FULLY GLAZED SHOP WINDOW
DW6	1800	2100	ALUMINIUM FULLY GLAZED	SW4	2925	2400	AL FULLY GLAZED SHOP WINDOW
DW7	1500	2100	ALUMINIUM FULLY GLAZED	SW5	2875	2400	AL FULLY GLAZED SHOP WINDOW
				SW6	2000	300	AL FULLY GLAZED SHOP WINDOW
				SW7	1500	300	AL FULLY GLAZED SHOP WINDOW
				SW8	1475	2400	AL FULLY GLAZED SHOP WINDOW
				SW9	1150	2400	AL FULLY GLAZED SHOP WINDOW
				SW10	750	300	AL FULLY GLAZED SHOP WINDOW
				BV1	3700	450	AL FULLY GLAZED BASEMENT WINDOW
				BV2	3600	450	AL FULLY GLAZED BASEMENT WINDOW
				BV3	3025	450	AL FULLY GLAZED BASEMENT WINDOW
				BV4	2875	450	AL FULLY GLAZED BASEMENT WINDOW
				BV5	2000	450	AL FULLY GLAZED BASEMENT WINDOW
				BV6	1850	450	AL FULLY GLAZED BASEMENT WINDOW
				BV7	1200	450	AL FULLY GLAZED BASEMENT WINDOW

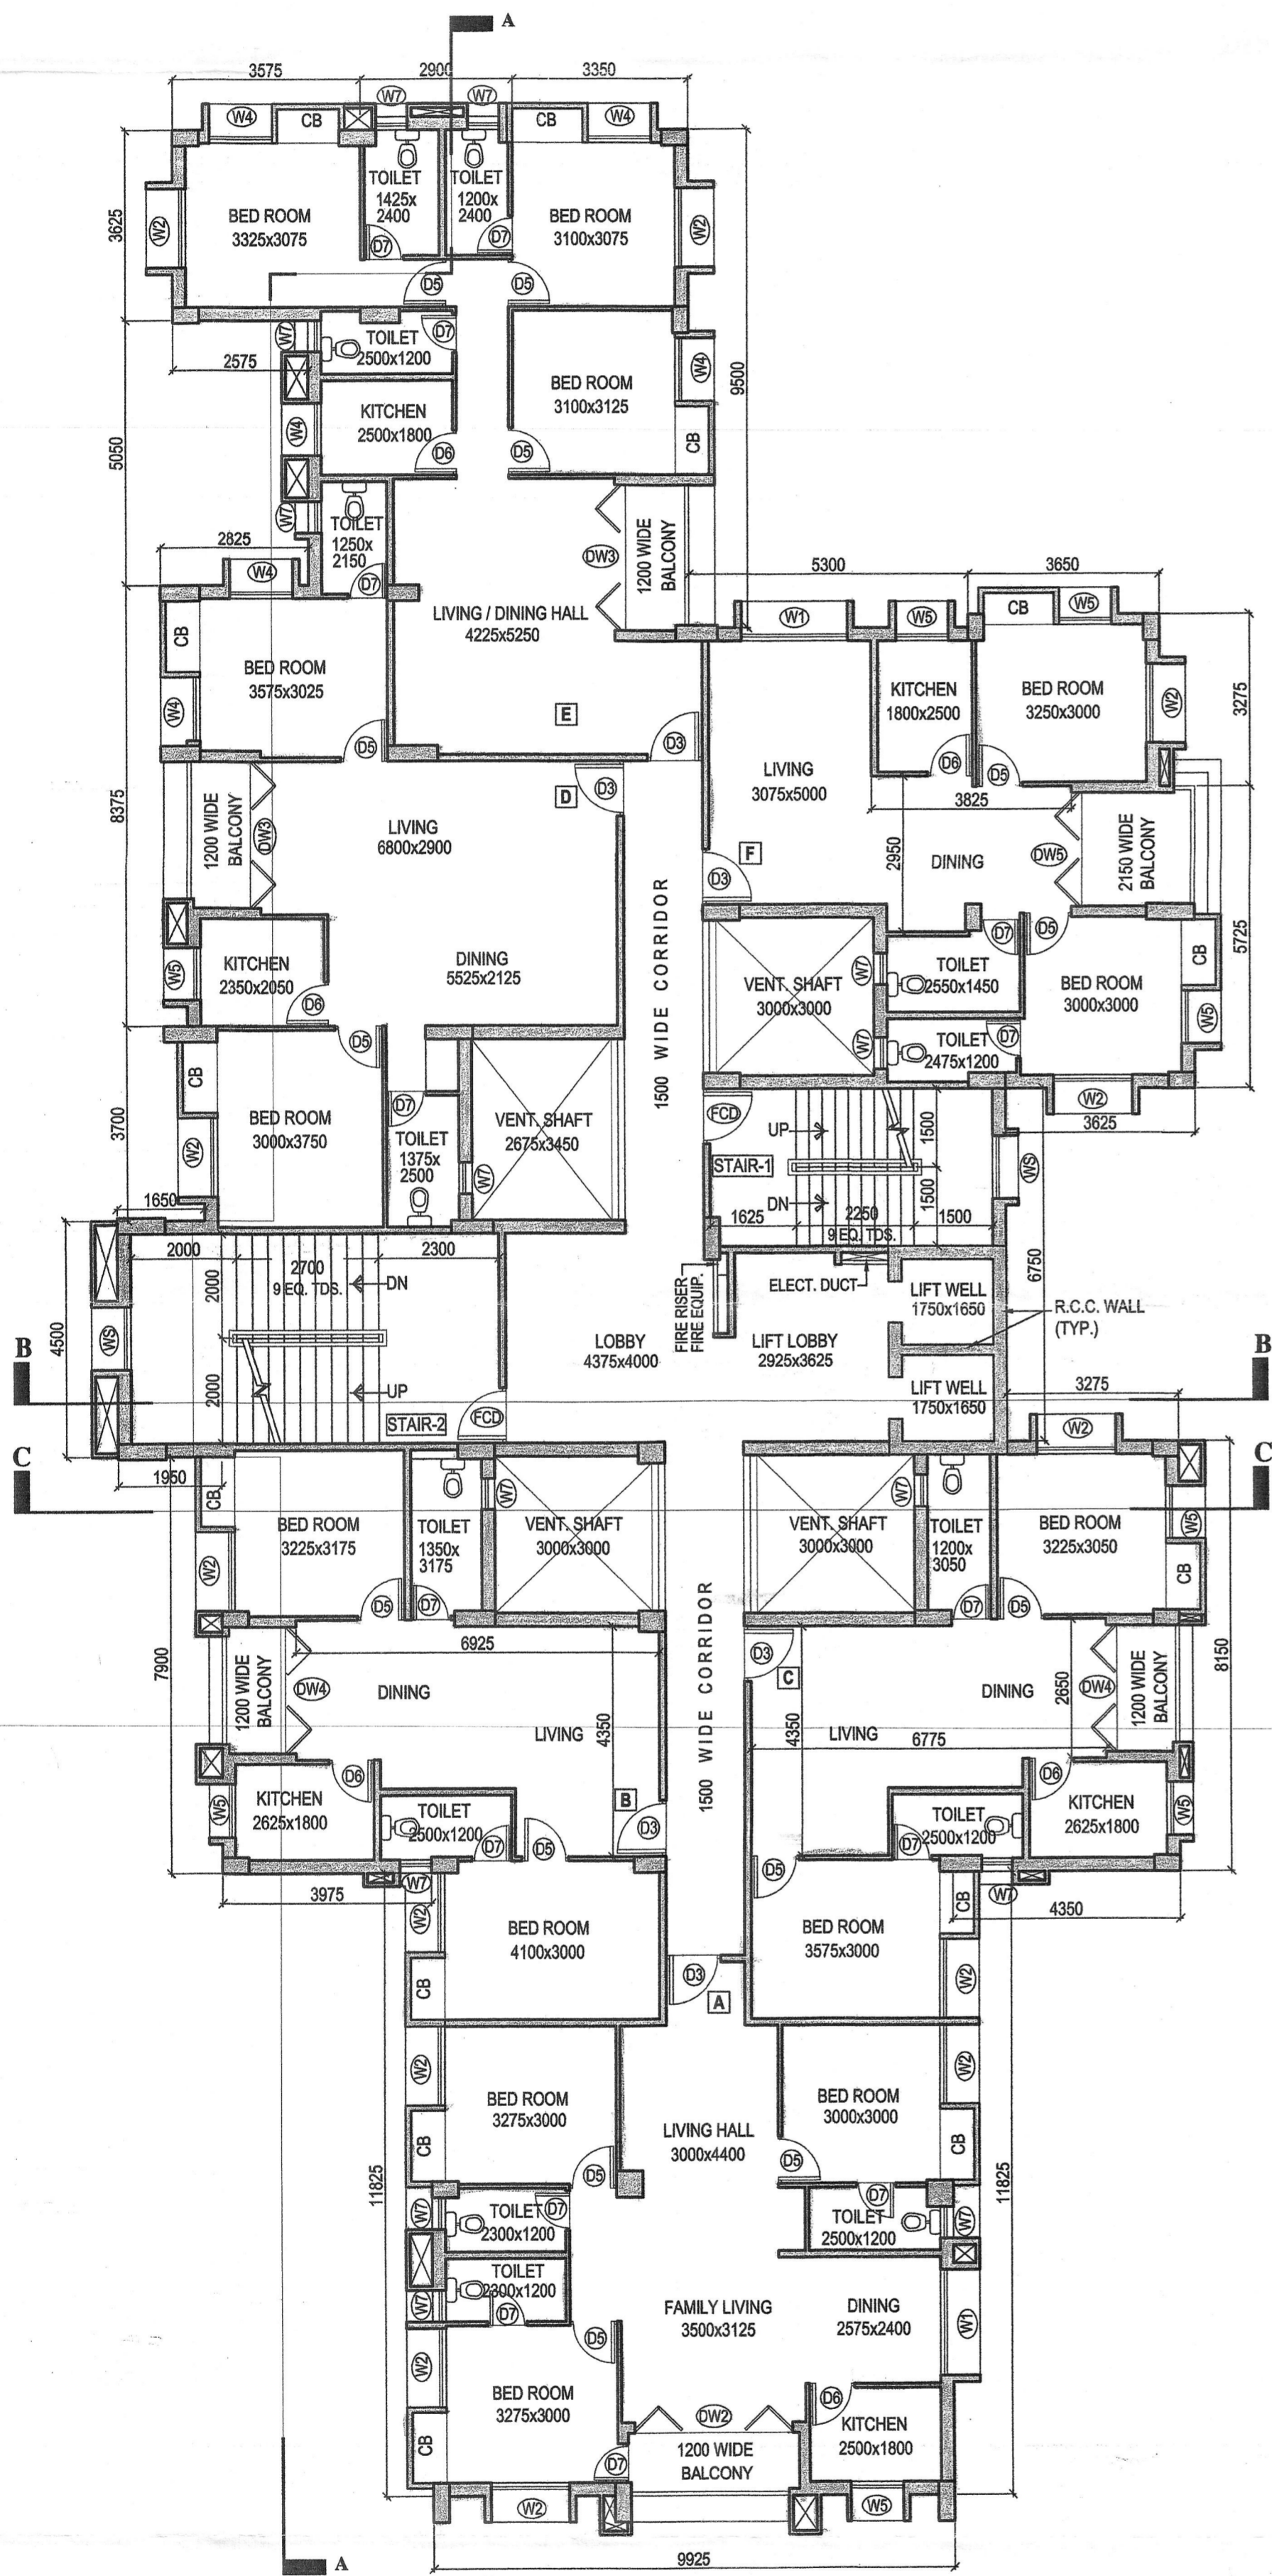

- NOTES:-**
1. ALL DIMENSIONS ARE IN mm. UNLESS NOTED OTHERWISE.
 2. FIG. DIMENSIONS SHOULD BE FOLLOWED. HENCE, DO NOT SCALE THE DRAWING.
 3. EXTERNAL WALLS ARE 250 mm, INTERNAL WALLS ARE 75 mm. AND INNER WALLS OF BALCONY ARE 200mm THICK AND WALL BETWEEN TWO FLATS & COMMON SPACE ARE 125mm THICK UNLESS NOTED OTHERWISE.
 4. ALL FIG. DIMENSIONS ARE EXCLUSIVE OF FINISHES.
 5. ALL BRICK WALLS WOULD BE UP TO SOFFIT OF BEAM / R.C.C. SLAB UNLESS NOTED OTHERWISE.
 6. TOILET CUBICLES PARTITION WALLS SHOULD BE UPTO LINTEL HEIGHT.
 7. 10 mm. DROP IN FLOOR FINISH SHALL BE PROVIDED IN TOILETS & BALCONIES UNLESS NOTED OTHERWISE.

CERTIFICATE OF ENGINEER :

CERTIFIED THAT THE FOUNDATION AND THE SUPER STRUCTURE OF THE BUILDING HAVE BEEN SO DESIGNED BY ME TO BE SAFE IN ALL RESPECT INCLUDING THE CONSIDERATION OF THE BEARING CAPACITY AND SETTLEMENT OF THE SUB-SOIL ETC. AS PER I.S.I. STANDARD / N.B. CODE.

CERTIFIED THAT THE PLAN HAS BEEN DESIGNED AND DRAWN UP STRICTLY ACCORDING TO THE BUILDING RULES FOR BARRACKPORE MUNICIPALITY.

Sashi Sharma
SASHI SHARMA
 L.B.S.-1/2, 2013-14
 Barrackpore Municipality
 Ph - 9007 50213

SIGNATURE OF ENGINEER / L.B.S.

DECLARATION OF OWNER :

DECLARED THAT I HAVE GONE THROUGH THE BUILDING BY LAWS FOR MUNICIPALITY AND ALSO UNDERTAKE TO ABIDE BY THOSE RULES DURING CONSTRUCTION OF THE BUILDING. CERTIFIED THAT I SHALL NOT ON A LATER DATE MAKE ANY ALTERATION TO THIS PLAN DURING CONSTRUCTION. I SHALL BE FULLY RESPONSIBLE FOR ANY VIOLATION OF THE BUILDING RULES AS WELL AS THE SANCTIONED BUILDING PLAN.

Sashi Sharma
GROUND 2 SKYE VENTURES LLP
 Designate Partner
 As Constituted Attorney of
 Prudential Estates Pvt. Ltd.

SIGNATURE OF OWNERS / C.P.A.

THIRD TO SIXTH FLOOR PLAN & ROOF PLAN

Sashi Sharma
SASHI SHARMA
 L.B.S.-1/2, 2013-14
 Barrackpore Municipality
 Ph - 9007 50213

SIGNATURE OF L.B.S.

PROPOSED B+G+VI STORIED RESIDENTIAL CUM COMMERCIAL APARTMENT BUILDING ON R.S. DAG NO.- 140, 141, 142, 143; KHATIAN NO.- 242, 508, 621, 622; MOUZA - CHANAK, J.L. NO.- 4; MUNICIPAL HOLDING NO.- 6(4), S.N. BANERJEE ROAD; WARD NO.- 21; UNDER BARRACKPORE MUNICIPALITY, P.S. :- TITAGARH, DIST. :- NORTH 24 PARGANAS.

TYPE OF DRAWING: MUNICIPAL DRAWING

DRAWN BY: PARAMA	DESIGNED BY: K.K.B	SCALE: 1:100
CHECKED BY: K.K.B	JOB NO.: K1902	DATE: 12.11.2021

MUKHERJEE & ALLIANCES ENGINEERS PVT. LTD.
 JABAKUSUM HOUSE, 34, CHITTARANJAN AVENUE
 KOLKATA - 700 012

DRAWING NO. K1902/002/M/AR-03 REV. 0